

MOTION DETECTING FLOODLIGHT DETAILS



Item Number 6230600 1 Light Wall Fixture Oil Rubbed Bronze Finish with Clear Seeded Glass New Haven

Specifications

- Height: 12.75"Width: 6.50"
- Extends: 8.63"
- Height from Center of Outlet Box: 4.88"
 Back Plate: H: 6.88" W: 4.50"
 Use (1) Medium (E26) Base Lamp, 100 Watt Maximum






DUTCHESS COUNTY, NY


WALL MOUNT LIGHT DETAILS

EXTERIOR LIGHTING SCHEDULE										
Symbol	Label	Quantity	Manufacturer	Catalog Number	Description	Lamp	Number Lamps	Lumens Per Lamp	Light Loss Factor	Wattage
74	А	2	LITHONIA LIGHTING (USED TO REPRESENT NEW HAVEN 1-LIGHT OUTDOOR WALL LANTERN)	-FMABSL 11F22	PROJECT: D323 CA 11" ABERDALE SCONCE W/ LILIAC FABRIC	LED	2	ABSOLUTE	1.0	8.9
\wedge	В	9	LITHONIA LIGHTING	OFLR 6LC 120 MO	LED FLOODLIGHT WITH TWO HEADS AND MOTION SENSOR	SIX LED	2	ABSOLUTE	1.0	22

ENGINEERING, DESIGN, & PLANS PREPARED BY: RENNIA ENGINEERING DESIGN, PLLC					REHO C STRE	
CIVIL • ENVIRONMENTAL • STRUCTURAL	TOWN OF AN	MENIA				
6 Dover Village Plaza, Suite 5, P.O. Box 400, Dover Plains, NY 12522 Tel: (845) 877-0555 Fax: (845) 877-0556 Copyright 2020, All Rights Reserved			LI	GHTIN	IG PLA	N
IT IS A VIOLATION OF NEW YORK STATE EDUCATION LAW FOR ANY PERSON TO ALTER THESE PLANS, SPECIFICATIONS OR REPORTS IN ANY WAY, UNLESS ACTING UNDER THE DIRECTION OF A LICENSED PROFESSIONAL ENGINEER.	DATE 10/19/2021	SCALE AS SHOWN	DESIGNED BY:	DRAWN BY:	CHECKED BY:	JOB NO. 15-004

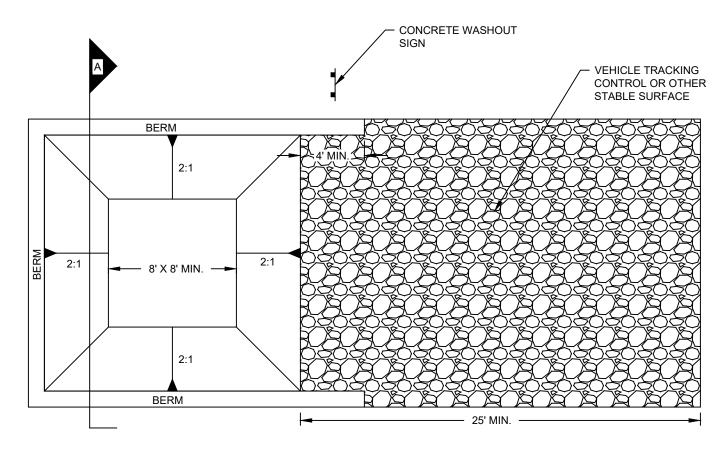

CONCRETE WASHOUT AREA PLAN

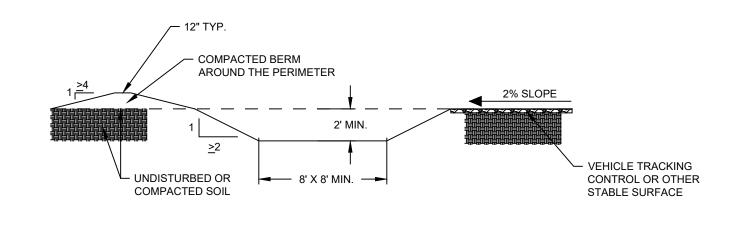

CONCRETE WASHOUT AREA DETAIL

SECTION A

INSTALLATION NOTES:


1. SEE PLAN VIEW FOR INSTALLATION LOCATION.


- 2. LOCATE THE FACILITY A MINIMUM OF 100 FEET FROM DRAINAGE SWALES, STORM DRAIN INLETS, WETLANDS, STREAMS AND OTHER SURFACE WATERS. THE CONCRETE WASHOUT AREA MUST BE INSTALLED WITH AN IMPERMEABLE LINER (10 MIL MIN. THICKNESS) OR SURFACE STORAGE ALTERNATIVES USING PREFABRICATED CONCRETE WASHOUT DEVICES OR A LINED ABOVE GROUND STORAGE ARE TO BE USED.
- 3. THE CONCRETE WASHOUT AREA SHALL BE INSTALLED PRIOR TO CONCRETE PLACEMENT ON SITE.
- THE CONCRETE WASHOUT AREA SHALL INCLUDE A FLAT SUBSURFACE PIT THAT IS AT LEAST 8' BY 8' SLOPES LEADING OUT OF THE SURBSURFACE PIT SHALL BE 2:1 OR FLATTER. THE PIT SHALL BE AT LEAST 2' DEEP.
- 5. BERM SURROUNDING SIDES AND BACL OF THE CONCRETE WASHOUT AREA SHALL HAVE A MINIMUM HEIGHT OF 1'.
- VEHICLE TRACKING PAD SHALL BE SLOPED 2% TOWARDS THE CONCRETE WASHOUT AREA.
- 7. SIGNS SHALL BE PLACED AT THE CONSTRUCTION ENTRANCE, AT THE CONCRETE WASHOUT AREA, AND ELSEWHERE AS NECESSARY TO CLEARLY INDICATE THE LOCATION OF THE CONCRETE WASHOUT AREA TO OPERATORS OF CONCRETE TRUCKS AND PUMP RIGS.
- 8. USE EXCAVATED MATERIAL FOR PERIMETER BERM CONSTRUCTION.

MAINTENANCE NOTES:

- INSPECT BEST MANAGEMENT PRACTICES (BMPs) EACH WORKDAY, AND MAINTAIN THEM IN EFFECTIVE OPERATING CONDITION. MAINTENANCE OF BMPs SHOULD BE PROACTIVE, NOT REACTIVE. INSPECT BMPs AS SOON AS POSSIBLE (AND ALWAYS WITHIN 24 HOURS) FOLLOWING A STORM THAT CAUSES SURFACE EROSION, AND PERFORM NECESSARY MAINTENANCE.
- 2. FREQUENT OBSERVATIONS AND MAINTENANCE ARE NECESSARY TO MAINTAIN BMPs IN EFFECTIVE OPERATING CONDITION. INSPECTIONS AND CORRECTIVE MEASURES SHOULD BE DOCUMENTED THOROUGHLY.
- 3. WHERE BMPs HAVE FAILED, REPAIR OR REPLACEMENT SHOULD BE INITIATED UPON DISCOVERY OF THE FAILURE.
- 4. THE CONCRETE WASHOUT AREA SHALL BE REPAIRED, CLEANED, OR ENLARGED AS NECESSARY TO MAINTAIN CAPACITY FOR CONCRETE WASTE, CONCRETE MATERIALS, ACCUMULATED IN PIT, SHALL BE REMOVED ONCE THE MATERIALS HAVE REACHED A 75% CAPACITY.
- 5. CONCRETE WASHOUT WATER, WASTED PIECES OF CONCRETE AND ALL OTHER DEBRIS IN THE SUBSURFACE PIT SHALL BE TRANSPORTED FROM THE JOB SITE IN A WATER-TIGHT CONTAINER AND DISPOSED OF PROPERLY.
- 6. THE CONCRETE WASHOUT AREA SHALL REMAIN IN PLACE UNTIL ALL CONCRETE FOR THE PROJECT IS PLACED.
- 7. WHEN THE CONCRETE WASHOUT AREA IS REMOVED, COVER THE DISTURBED AREA WITH TOP SOIL, SEED AND MULCH OR OTHERWISE STABILIZED IN A MANNER APPROVED BY THE LOCAL JURISDICTION.

6" BOLLARD DETAIL

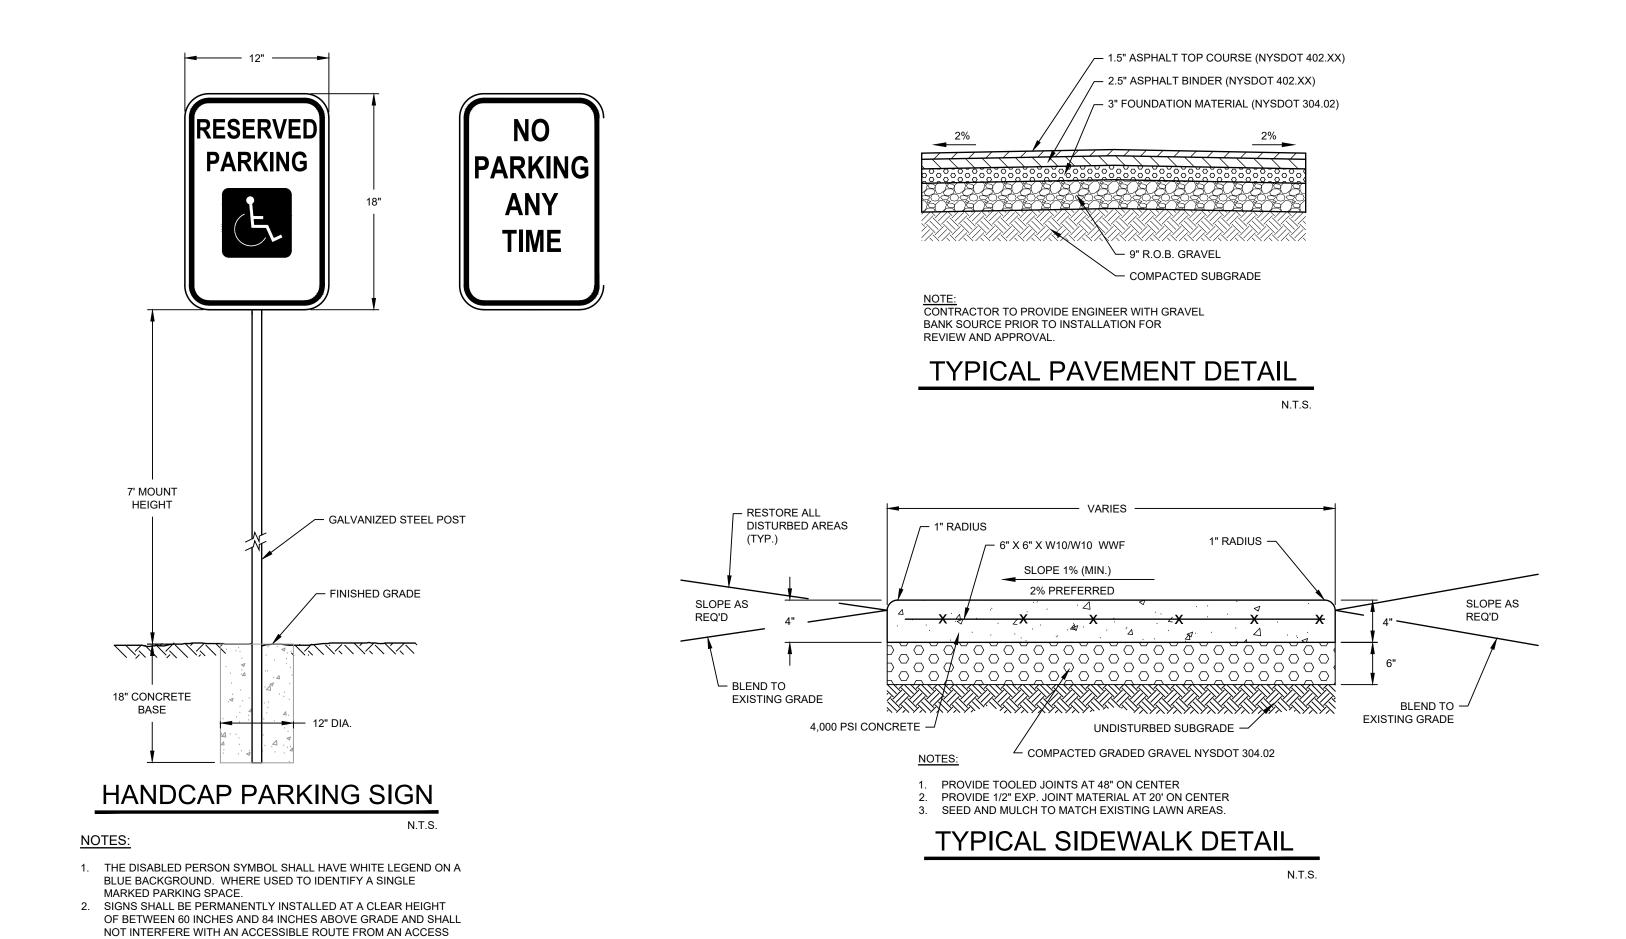

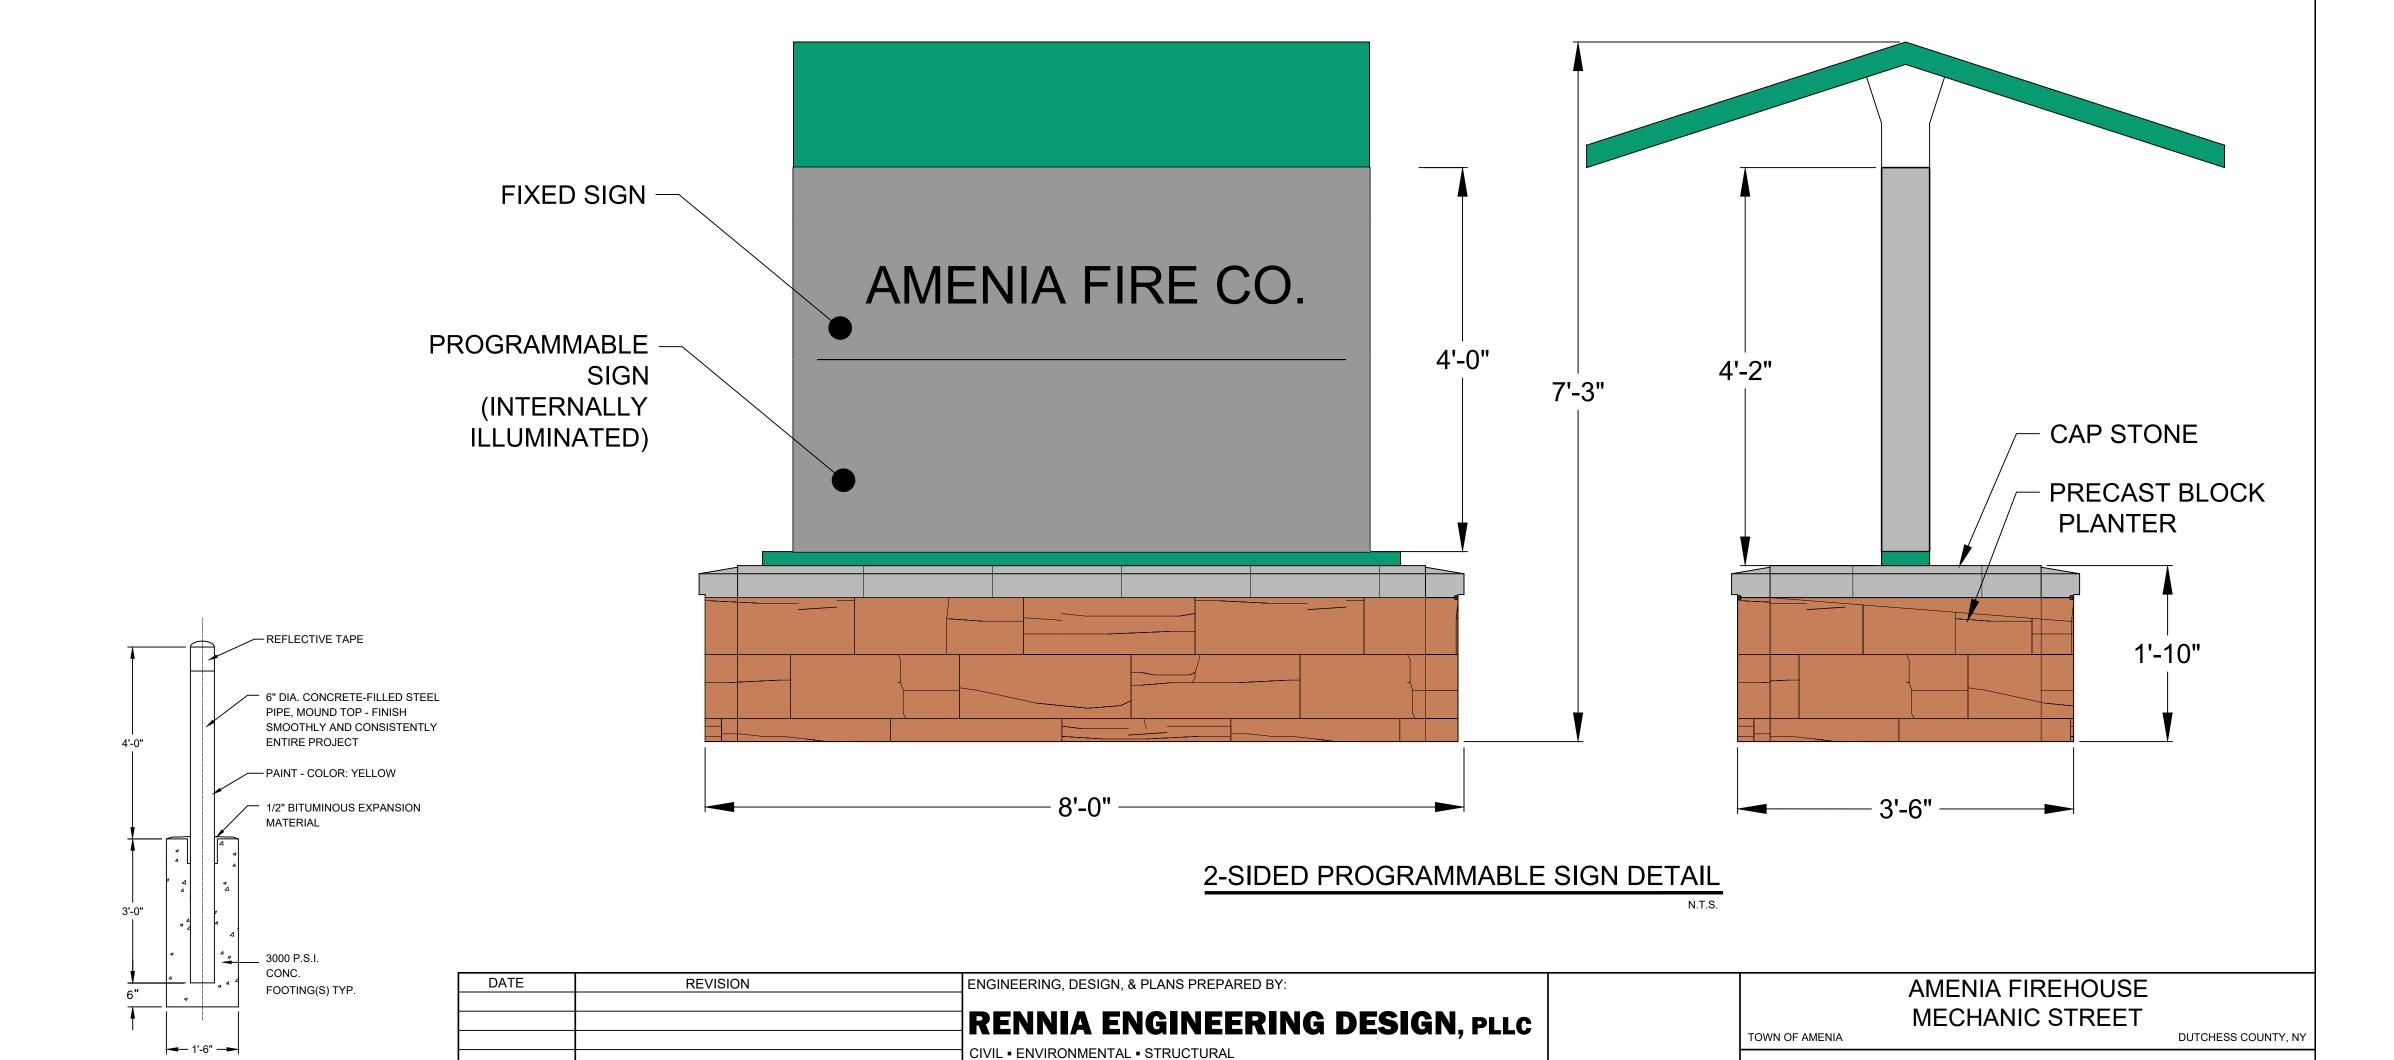

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VAY, UNLESS ACTING UNDER THE DIRECTION OF A LICENSED PROFESSIONAL ENGINEER.

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INTERNATIONAL ACCESSIBILITY —

SYMBOL AT EACH SPACE

A.D.A. PARKING STALL DETAIL

DETAILS

15-004

RED


10/19/2021

AS SHOWN


WHEEL CHAIR ONLY SIGN

- ACCESS AISLE.

4" PAINTED WHITE STRIPES 24" APART

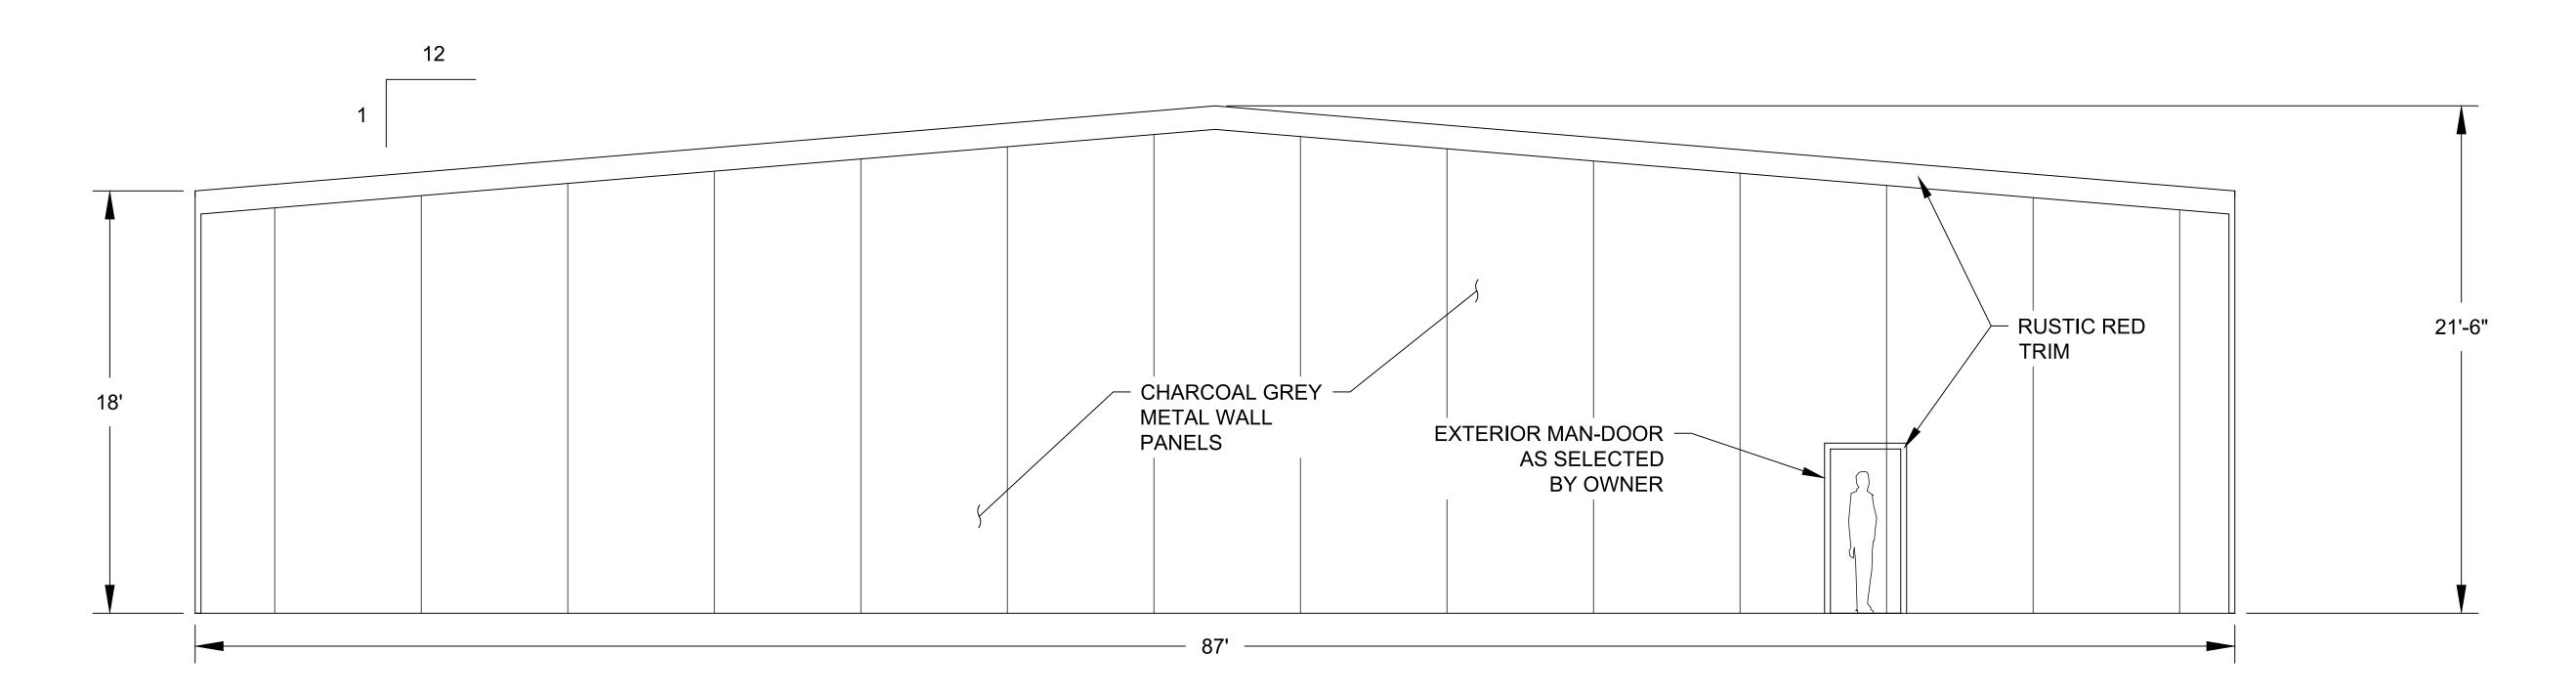

NORTH ELEVATION

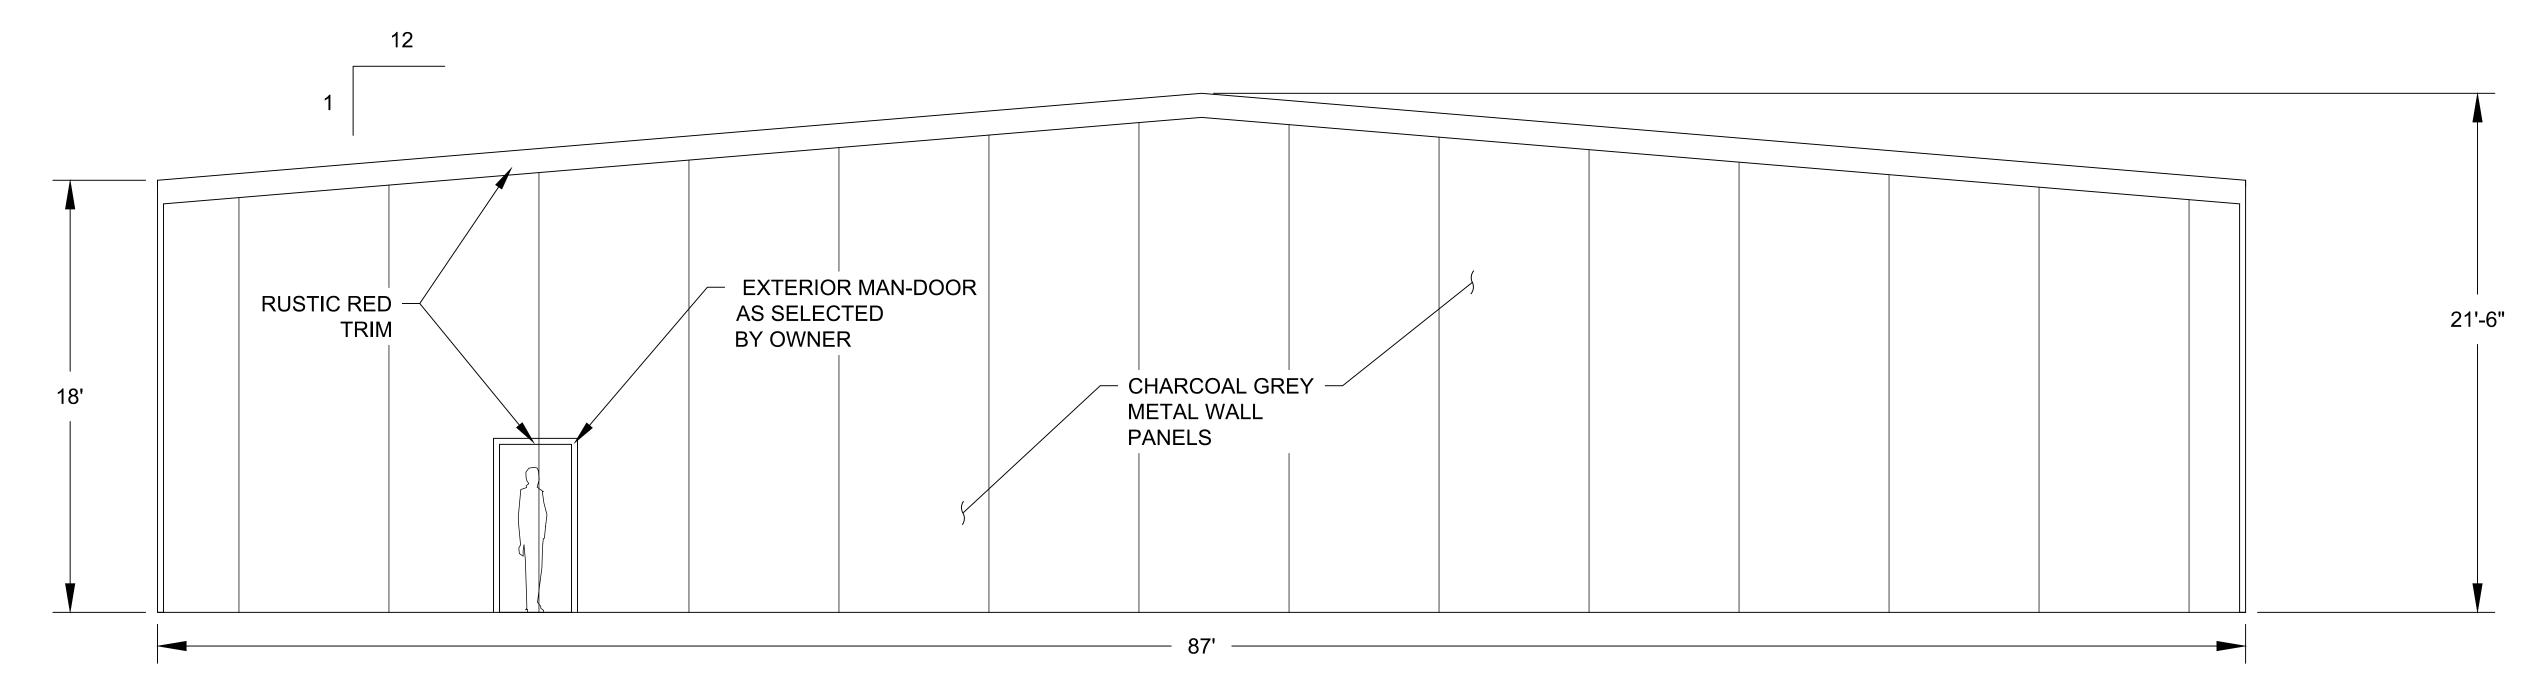

SOUTH ELEVATION

SITE DATA

ZONING DISTRICT: "HM" HAMLET-MIXED USE
LOT SIZE: 4.29 ACRES
TAX GRID No.: 132000-7167-14-279456
PROPERTY ADDRESS: 36 MECHANIC ST.
AMENIA, NY 12501
PROPERTY OWNER: AMENIA FIRE COMPANY NO. 1, INC.
36 MECHANIC ST.
AMENIA, NY 12501

DATE REVISION		ENGINEERING, DESIGN, & PLANS PREPARED BY:		
		RENNIA ENGINEERING DESIGN, PLLC CIVIL & ENVIRONMENTAL ENGINEERING		
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TOWN OF AMENIA MECHANIC STREET

DUTCHESS COUNTY, NY

AMENIA FIREHOUSE

NORTH/SOUTH BUILDING ELEVATIONS

DATE SCALE DESIGNED BY: DRAWN BY: CHECKED BY: JOB NO. SHEET NO. 10/19/2021 NTS RED RED RAR 15-004 5 of 6

